PROJECT INFORMATION:

PROPOSED UNMANNED COMMERCIAL COMMUNICATIONS TOWER WITH PERSONAL WIRELESS

SERVICE FACILITIES INCLUDING THE INSTALLATION OF A 95' MONOPINE WITH ANTENNAS AND ASSOCIATED EQUIPMENT WITHIN A PROPOSED FENCED MULTI-CARRIER WIRELESS EQUIPMENT

SITE ADDRESS: 15 ROCKLEDGE ROAD NELSONVILLE, NY 1051 PROPERTY OWNER: DOUGLAS W. LOGAN

HOMELAND TOWERS, LLC 9 HARMONY STREET, 2ND FLOOR

P.O. BOX 188

COLD SPRING, NY 10516

ELECTRICAL CONTACT: CENTRAL HUDSON GAS & ELECTRIC CONTACT: CUSTOMER SERVICE PHONE: (800) 527-2714

TELCO CONTACT: (800) 843-2255 N41°25'20.32" LATITUDE: LONGITUDE: W73°56'27.56"

LAT/LONG TYPE: NORTH AMERICAN DATUM OF 1983 (NAD83)

ELEVATION: ±363.15

JURISDICTION: VILLAGE OF NELSONVILLE **COUNTY:** PUTNAM COUNTY TAX PARCEL: 49.6-1-7 LOT SIZE: 9.63 ACRES


ZONING DISTRICT: MR "MOUNTAIN RESIDENTIAL"

CURRENT USE: UNDEVELOPED


PROPOSED USE: COMMERCIAL COMMUNICATIONS TOWER WITH PERSONAL WIRELESS SERVICE FACILITIES

CONSTRUCTION DRAWINGS SITE NUMBER: NY170 SITE NAME: NELSONVILLE


15 ROCKLEDGE ROAD VILLAGE OF NELSONVILLE PUTNAM COUNTY, NY

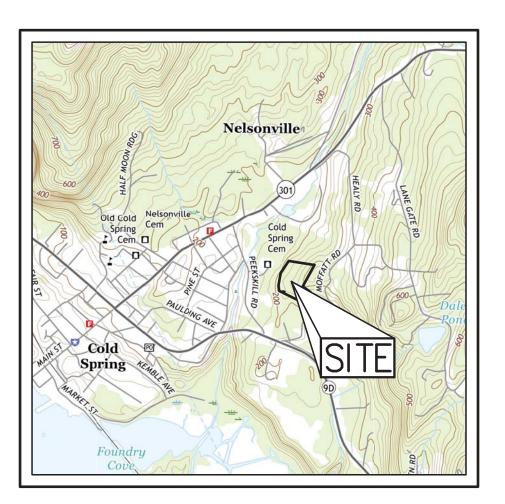




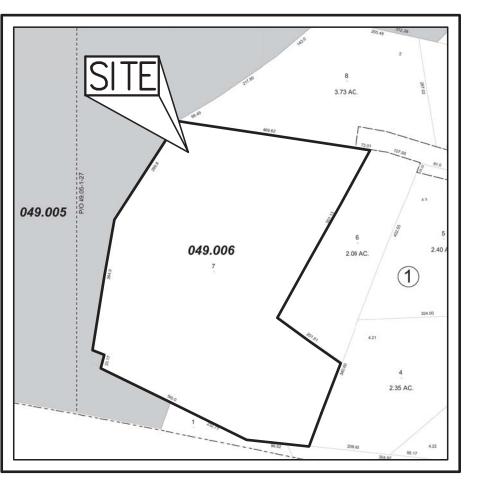



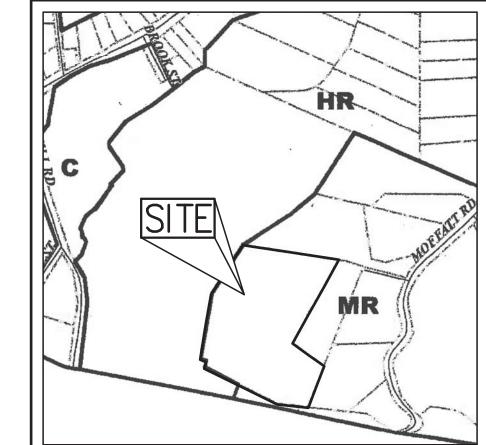

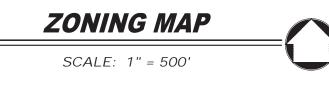

	ZONING LEGEND
C HR	COMMERCIALHILLSIDE RESIDENTIAL
MR	MOUNTAIN RESIDENTIAL*

PROJECT CONTACTS:

SITE PLANNER & CIVIL ENGINEER



JMC PLANNING ENGINEERING LANDSCAPE ARCHITECTURE & LAND SURVEYING, PLLC 120 BEDFORD ROAD ARMONK, NY 10504

APPLICANT:



HOMELAND TOWERS, LLC 9 HARMONY STREET, 2ND FLOOR DANBURY, CT 06810 (203) 297-6345

ATTORNEY:

SNYDER & SNYDER, LLP 94 WHITE PLAINS ROAD, TARRYTOWN, NY 10591 (914) 333-0700

SURVEYOR:

BADEY & WATSON SURVEYING & ENGINEERING, PC *3063 ROUTE 9* COLD SPRING, NY 10516 (845) 265-9217

NEPA CONSULTANT:

CBRE TELECOM SERVICES, INC. 4 WEST RED OAK LANE WHITE PLAINS, NY 10604 (914) 694-9600

ELECTRICAL ENGINEER:

OLA CONSULTING ENGINEERS 50 BROADWAY HAWTHORNE, NY 10532 (914) 747-2800

JMC DRAWINGS:

COVER SHEET OVERALL SITE PLAN TREE REMOVAL PLAN SITE LAYOUT AND LANDSCAPING PLAN SITE GRADING, UTILITIES, AND EROSION & SEDIMENT CONTROL PLAN ACCESS DRIVEWAY PROFILE CONSTRUCTION DETAILS CONSTRUCTION DETAILS CD-9 **CONSTRUCTION DETAILS** ROCKLEDGE ROAD / EASEMENT

OLA CONSULTING ENGINEERS DRAWINGS:

E1.1 ELECTRICAL SITE PLAN E1.2 UTILITY DETAILS

Previous Editions Obsolete

SITE NAME: NELSONVILLE

SITE NUMBER: NY170

E1.3 **GROUNDING PLAN AND DETAILS**

IMPROVEMENT PLAN

GENERAL CONSTRUCTION NOTES APPLY TO ALL WORK HEREIN:

1. PRIOR TO CONSTRUCTION, THE CONTRACTOR SHALL CALL 811 "DIG SAFELY" (1-800-962-7962) TO HAVE UNDERGROUND UTILITIES LOCATED. EXPLORATORY EXCAVATIONS SHALL COMPLY WITH CODE 753 REQUIREMENTS. NO WORK SHALL COMMENCE UNTIL ALL THE OPERATORS HAVE NOTIFIED THE CONTRACTOR THAT THEIR UTILITIES HAVE BEEN LOCATED. THE CONTRACTOR SHALL BE RESPONSIBLE FOR THE PRESERVATION OF ALL PUBLIC AND PRIVATE UNDERGROUND AND SURFACE UTILITIES AND STRUCTURES AT OR ADJACENT TO THE SITE OF CONSTRUCTION, INSOFAR AS THEY MAY BE ENDANGERED BY HIS OPERATIONS. THIS SHALL HOLD TRUE WHETHER OR NOT THEY ARE SHOWN ON THE CONTRACT DRAWINGS. IF THEY ARE SHOWN ON THE DRAWINGS, THEIR LOCATIONS ARE NOT GUARANTEED EVEN THOUGH THE INFORMATION WAS OBTAINED FROM THE BEST AVAILABLE SOURCES, AND SHALL CONSTANTLY PROCEED WITH CAUTION TO ADDITIONAL OF LITERATURE OF CONSTANTLY PROCEED WITH CAUTION TO

. UNDER INDUSTRIAL CODE 753, CONTRACTOR SHALL NOTIFY ALL OPERATORS OF UTILITIES LOCATED IN THE AREA WHERE THE WORK IS TO BE PERFORMED PRIOR TO THE START OF THIS WORK SO THAT ALL THE VARIOUS UNDERGROUND UTILITY OPERATORS WILL BE ABLE TO LOCATE AND MARK THE LOCATIONS OF THEIR OWN UTILITIES. NO WORK SHALL COMMENCE UNTIL ALL THE OPERATORS HAVE NOTIFIED THE CONTRACTOR THAT THEIR UTILITIES HAVE BEEN LOCATED.

3. CONTRACTOR SHALL HAND DIG TEST PITS TO VERIFY THE LOCATION OF ALL EXISTING UNDERGROUND UTILITIES PRIOR TO THE START OF CONSTRUCTION, CONTRACTOR SHALL VERIFY EXISTING UTILITIES DEPTHS AND ADVISE OF ANY CONFLICTS WITH PROPOSED UTILITIES, IF CONFLICTS ARE PRESENT. THE OWNER'S FIELD REPRESENTATIVE, JMC AND THE APPLICABLE MUNICIPALITY OR AGENCY SHALL BE NOTIFIED IN WRITING. THE EXISTING/PROPOSED UTILITIES RELOCATION SHALL BE DESIGNED BY JMC.


. ALL CONSTRUCTION WORK SHALL BE PERFORMED IN ACCORDANCE WITH ALL SAFETY CODES. APPLICABLE SAFETY CODES MEAN THE LATEST EDITION INCLUDING ANY AND ALL AMENDMENTS, REVISIONS, AND ADDITIONS THERETO, TO THE FEDERAL DEPARTMENT OF LABOR, OCCUPATIONAL SAFETY AND HEALTH ADMINISTRATION'S OCCUPATIONAL SAFETY AND HEALTH STANDARDS (OSHA); AND APPLICABLE SAFETY, HEALTH REGULATIONS AND BUILDING CODES FOR CONSTRUCTION IN THE STATE OF NEW YORK. THE CONTRACTOR SHALL BE RESPONSIBLE FOR GUARDING AND PROTECTING ALL OPEN EXCAVATIONS IN ACCORDANCE WITH THE PROVISION OF SECTION 107-05 (SAFETY AND HEALTH REQUIREMENTS) OF THE NYSDOT STANDARD SPECIFICATIONS. IF THE CONTRACTOR PERFORMS ANY HAZARDOUS CONSTRUCTION PRACTICES, ALL OPERATIONS IN THE AFFECTED AREA SHALL BE DISCONTINUED AND IMMEDIATE ACTION SHALL BE TAKEN TO CORRECT THE SITUATION TO THE SATISFACTION OF THE APPROVAL AUTHORITY HAVING JURISDICTION.


5. CONTRACTOR SHALL MAINTAIN ACCESS TO ALL PROPERTIES AFFECTED BY THE SCOPE OF WORK SHOWN HEREON AT ALL TIMES TO THE SATISFACTION OF THE OWNER'S REPRESENTATIVE. RAMPING CONSTRUCTION TO PROVIDE ACCESS MAY BE CONSTRUCTED BY THE SUBBASE MATERIAL EXCEPT THAT TEMPORARY ASPHALT CONCRETE SHALL BE PLACED AS DIRECTED BY THE ENGINEER. THE CONTRACTOR SHALL BE RESPONSIBLE FOR PROVIDING SAFE PEDESTRIAN ACCESS AT ALL TIMES.

PRIOR TO OBTAINING A BUILDING PERMIT TO ALLOW ITS CONSTRUCTION, DETAILED DESIGN CALCULATIONS MUST BE PROVIDED TO ILLUSTRATE COMPLIANCE WITH ANSI TIA/EIA '222-F AND ANSI TIA 222-G "STRUCTURAL STANDARDS FOR ANTENNA SUPPORTING STRUCTURES AND ANTENNAS" AND THE NYS BUILDING CODE, FOR REVIEW AND ACCEPTANCE BY THE VILLAGE.


Call Before You Dig **■** Wait The Required Time Confirm Utility Response COPYRIGHT $^{\tiny{\textcircled{\tiny 0}}}$ 2020 by JMC $\,$ All Rights Reserved. No part of this document may be espect The Marks reproduced, stored in a retrieval system, or transmitted in any form or by means, electronic, mechanical, photocopying, recording or otherwise, without the prior written permission of JMC 800-962-7962 PLANNING, ENGINEERING, LANDSCAPE ARCHITECTURE & LAND SURVEYING, PLLC. Any modifications or alterations to this document without the written permission of JMC shall


ANY ALTERATION OF PLANS. SPECIFICATIONS, PLATS AND REPORTS BEARING THE SEAL OF A LICENSED PROFESSIONAL ENGINEER OR LICENSED LAND SURVEYOR IS A VIOLATION OF SECTION 7209 OF THE NEW YORK STATE EDUCATION LAW, EXCEPT AS PROVIDED FOR BY SECTION 7209, SUBSECTION 2

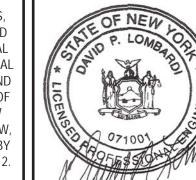


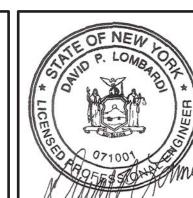



	TAX PARCELS:	49.6-1-7					
	NO.	REVISION	DATE	ВҮ		PD APPRO	OVED: JS
				Н	SCALE:	AS SHOW	N
1					DATE:	03/13/202	20
					PROJECT No:	16237	
LI CER					<i>DWG:</i> 16237-SITE	TAB: COVER	SCR: 9_COVEF
					DRAWING No:	COVER	3_0011
//,	/;					יחי	4
reu	101				(ルノー	-
20.7					_		

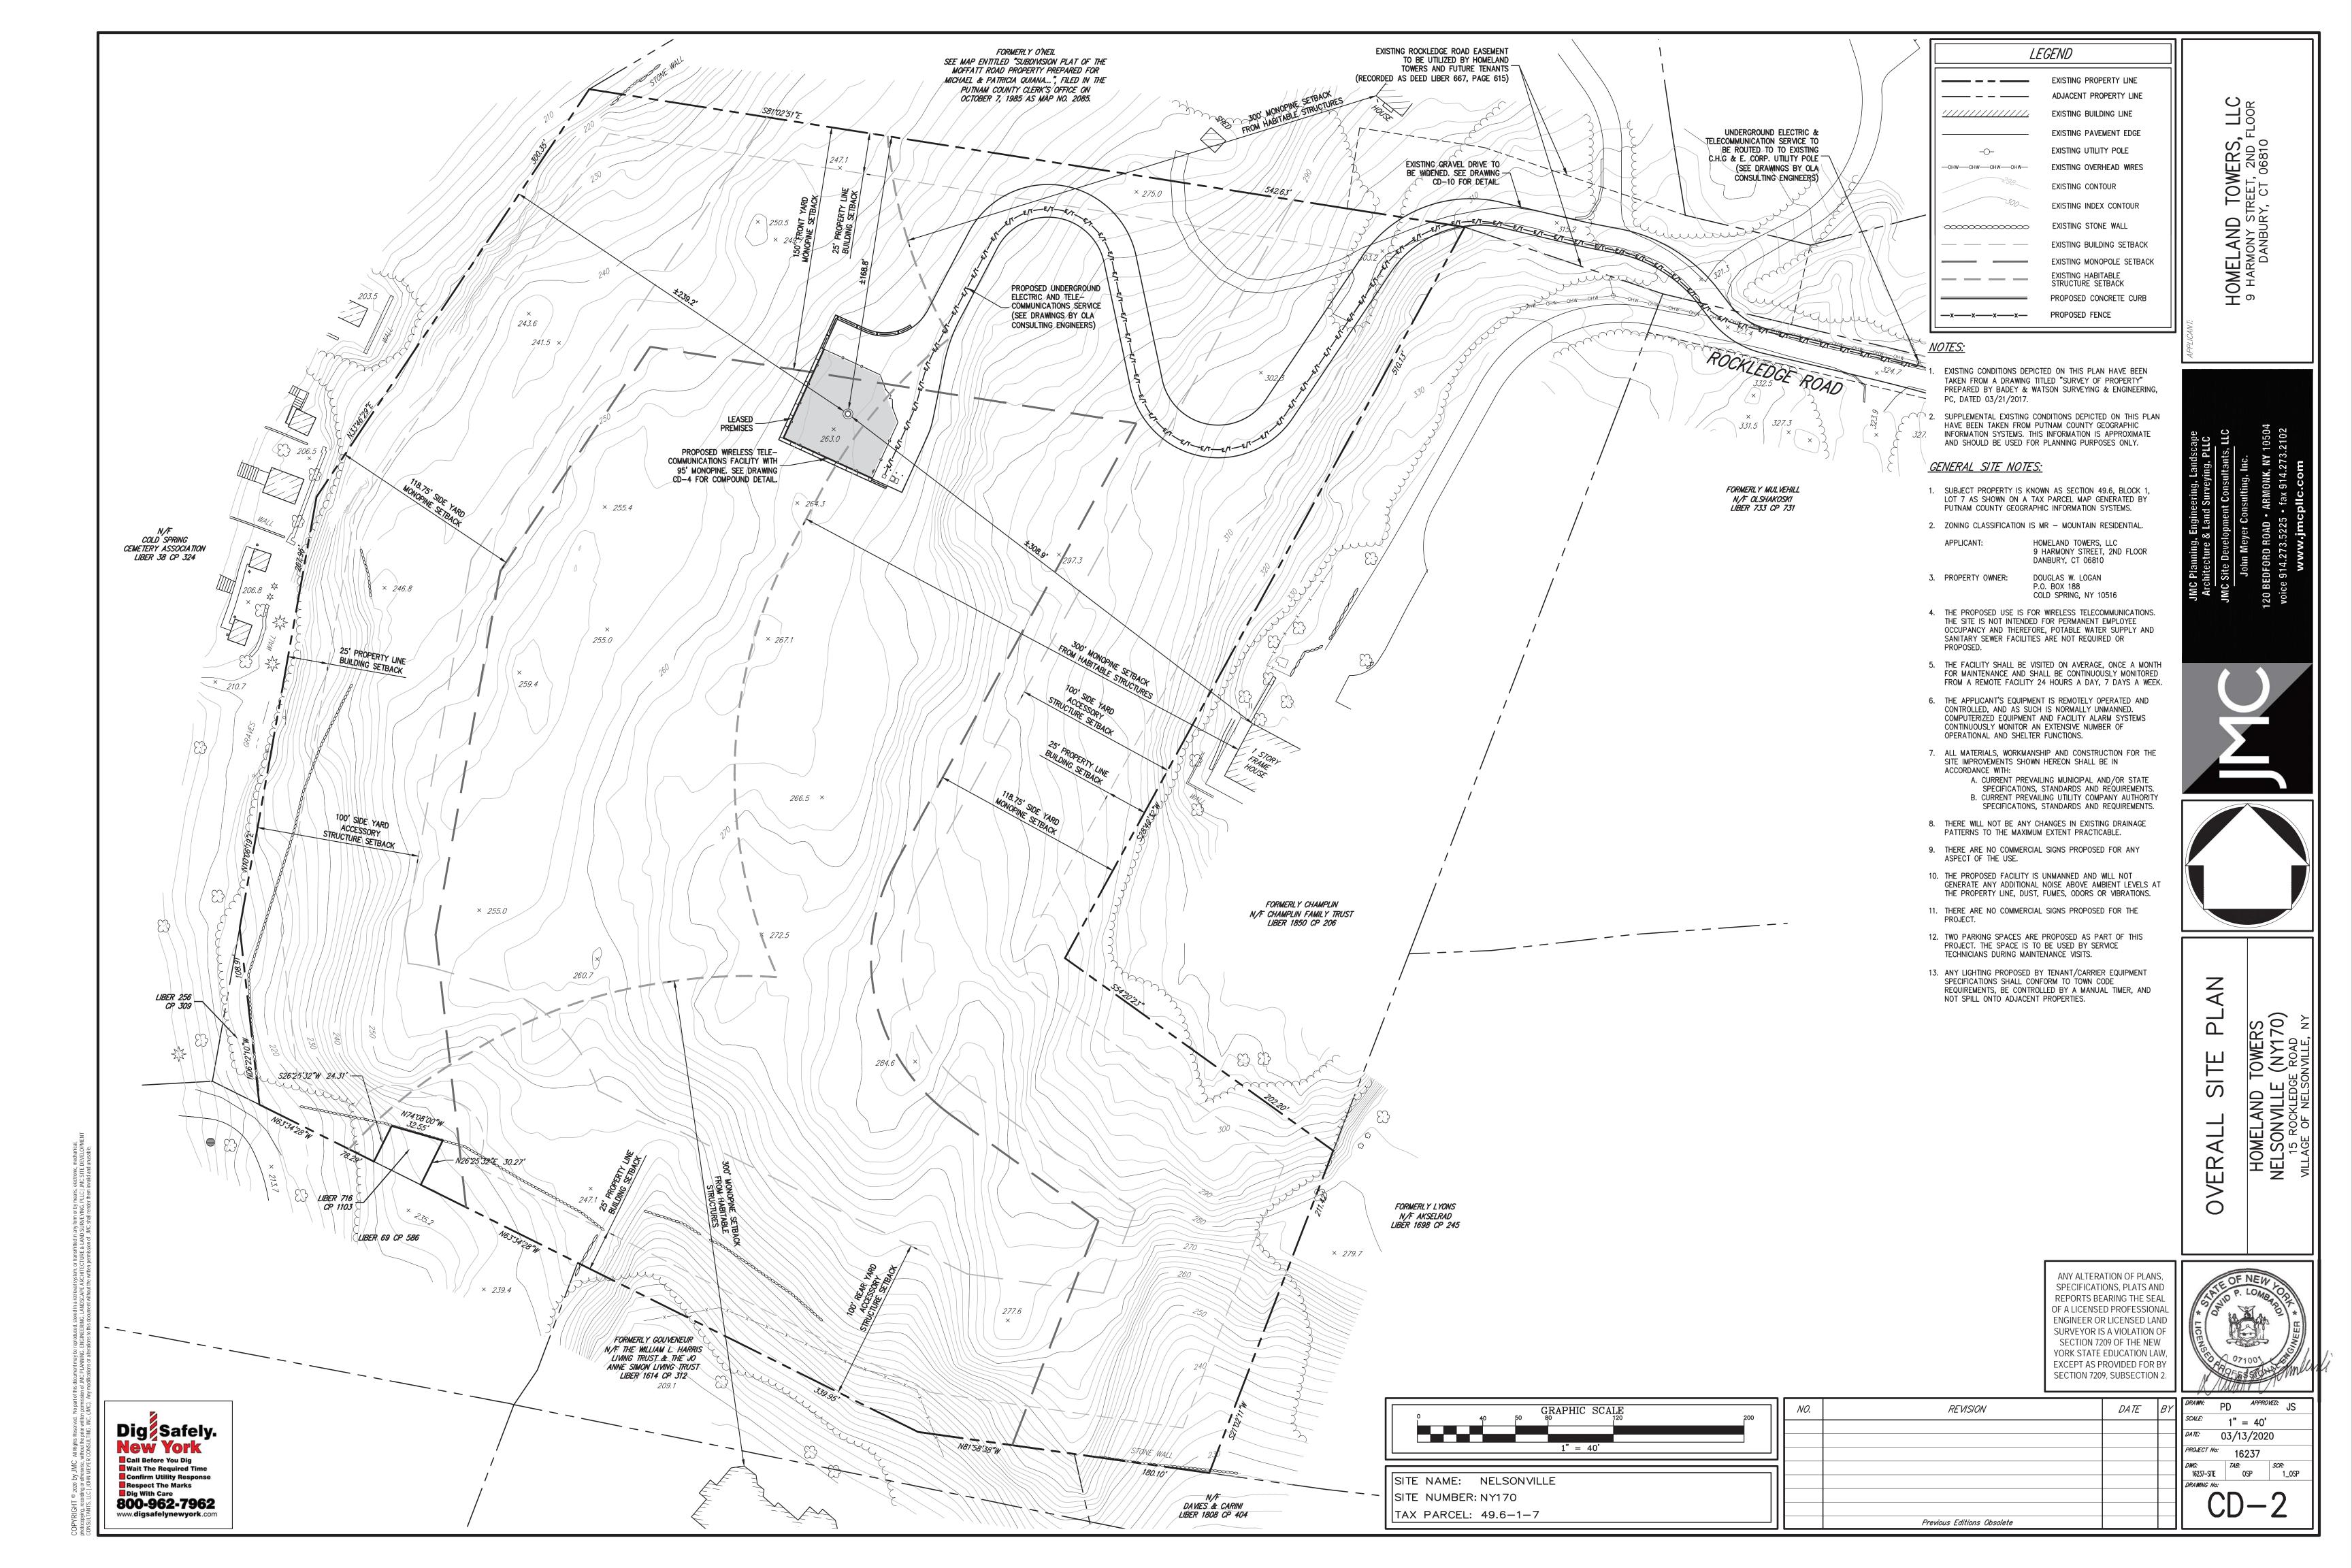

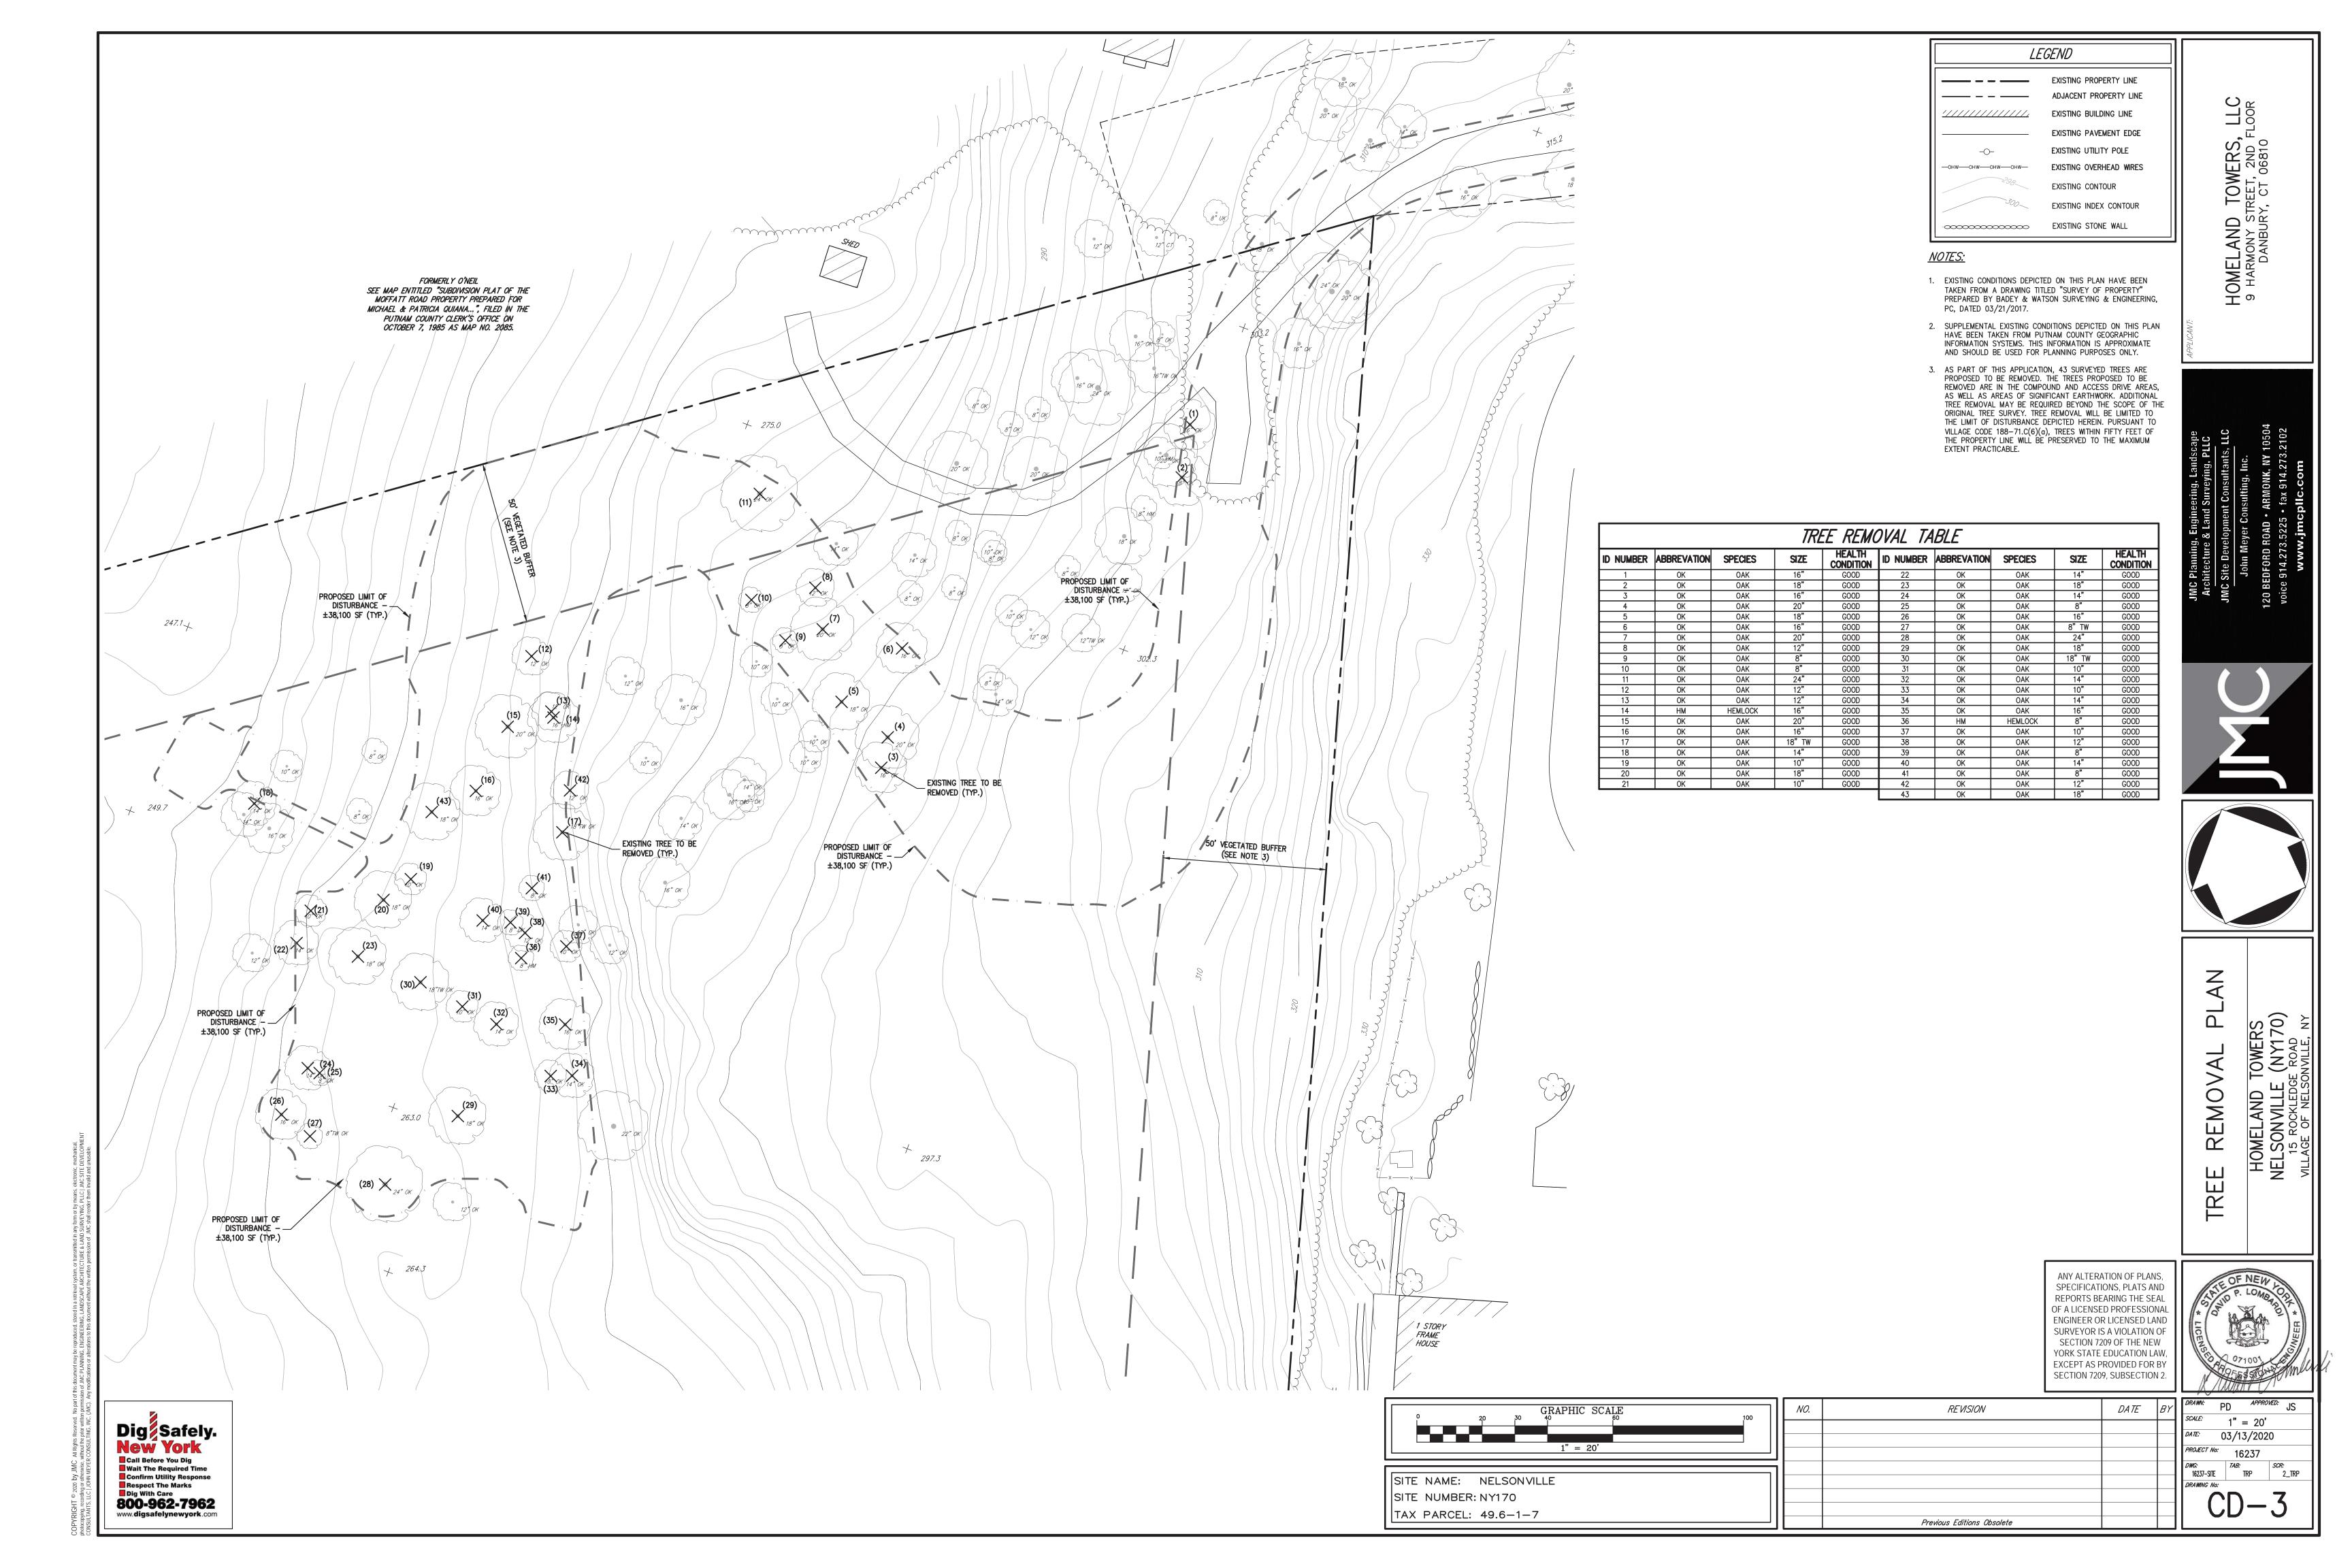


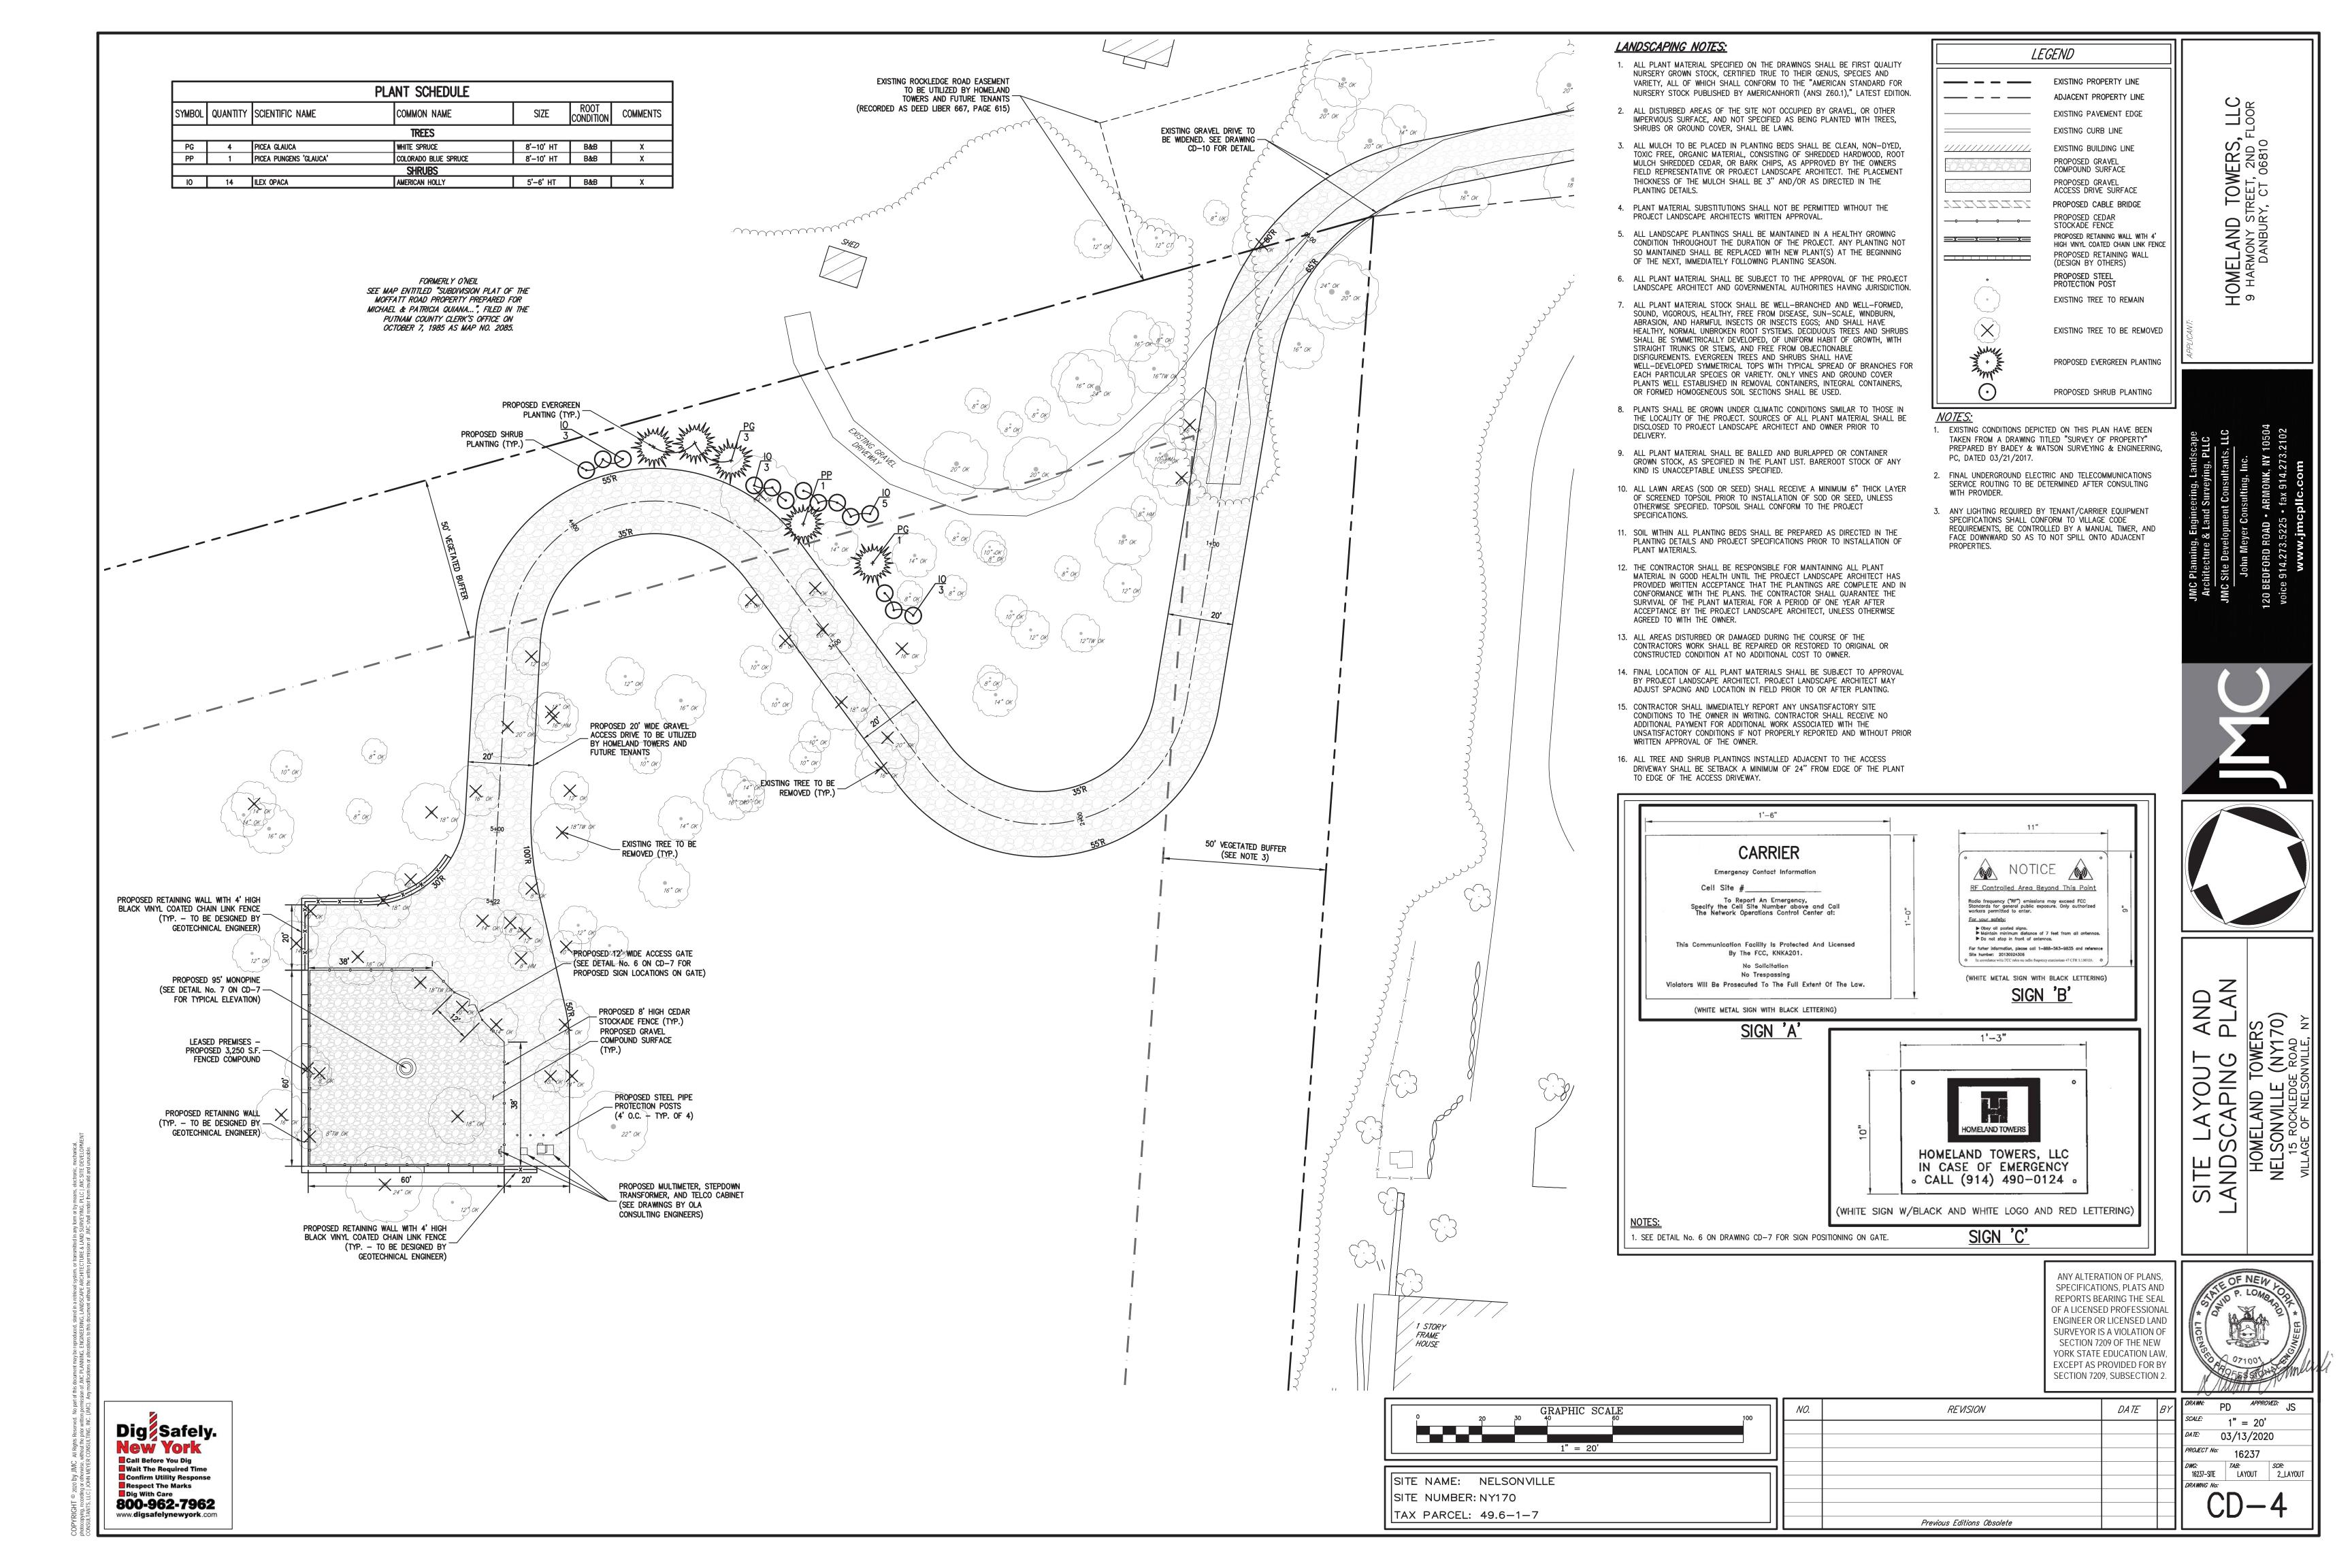

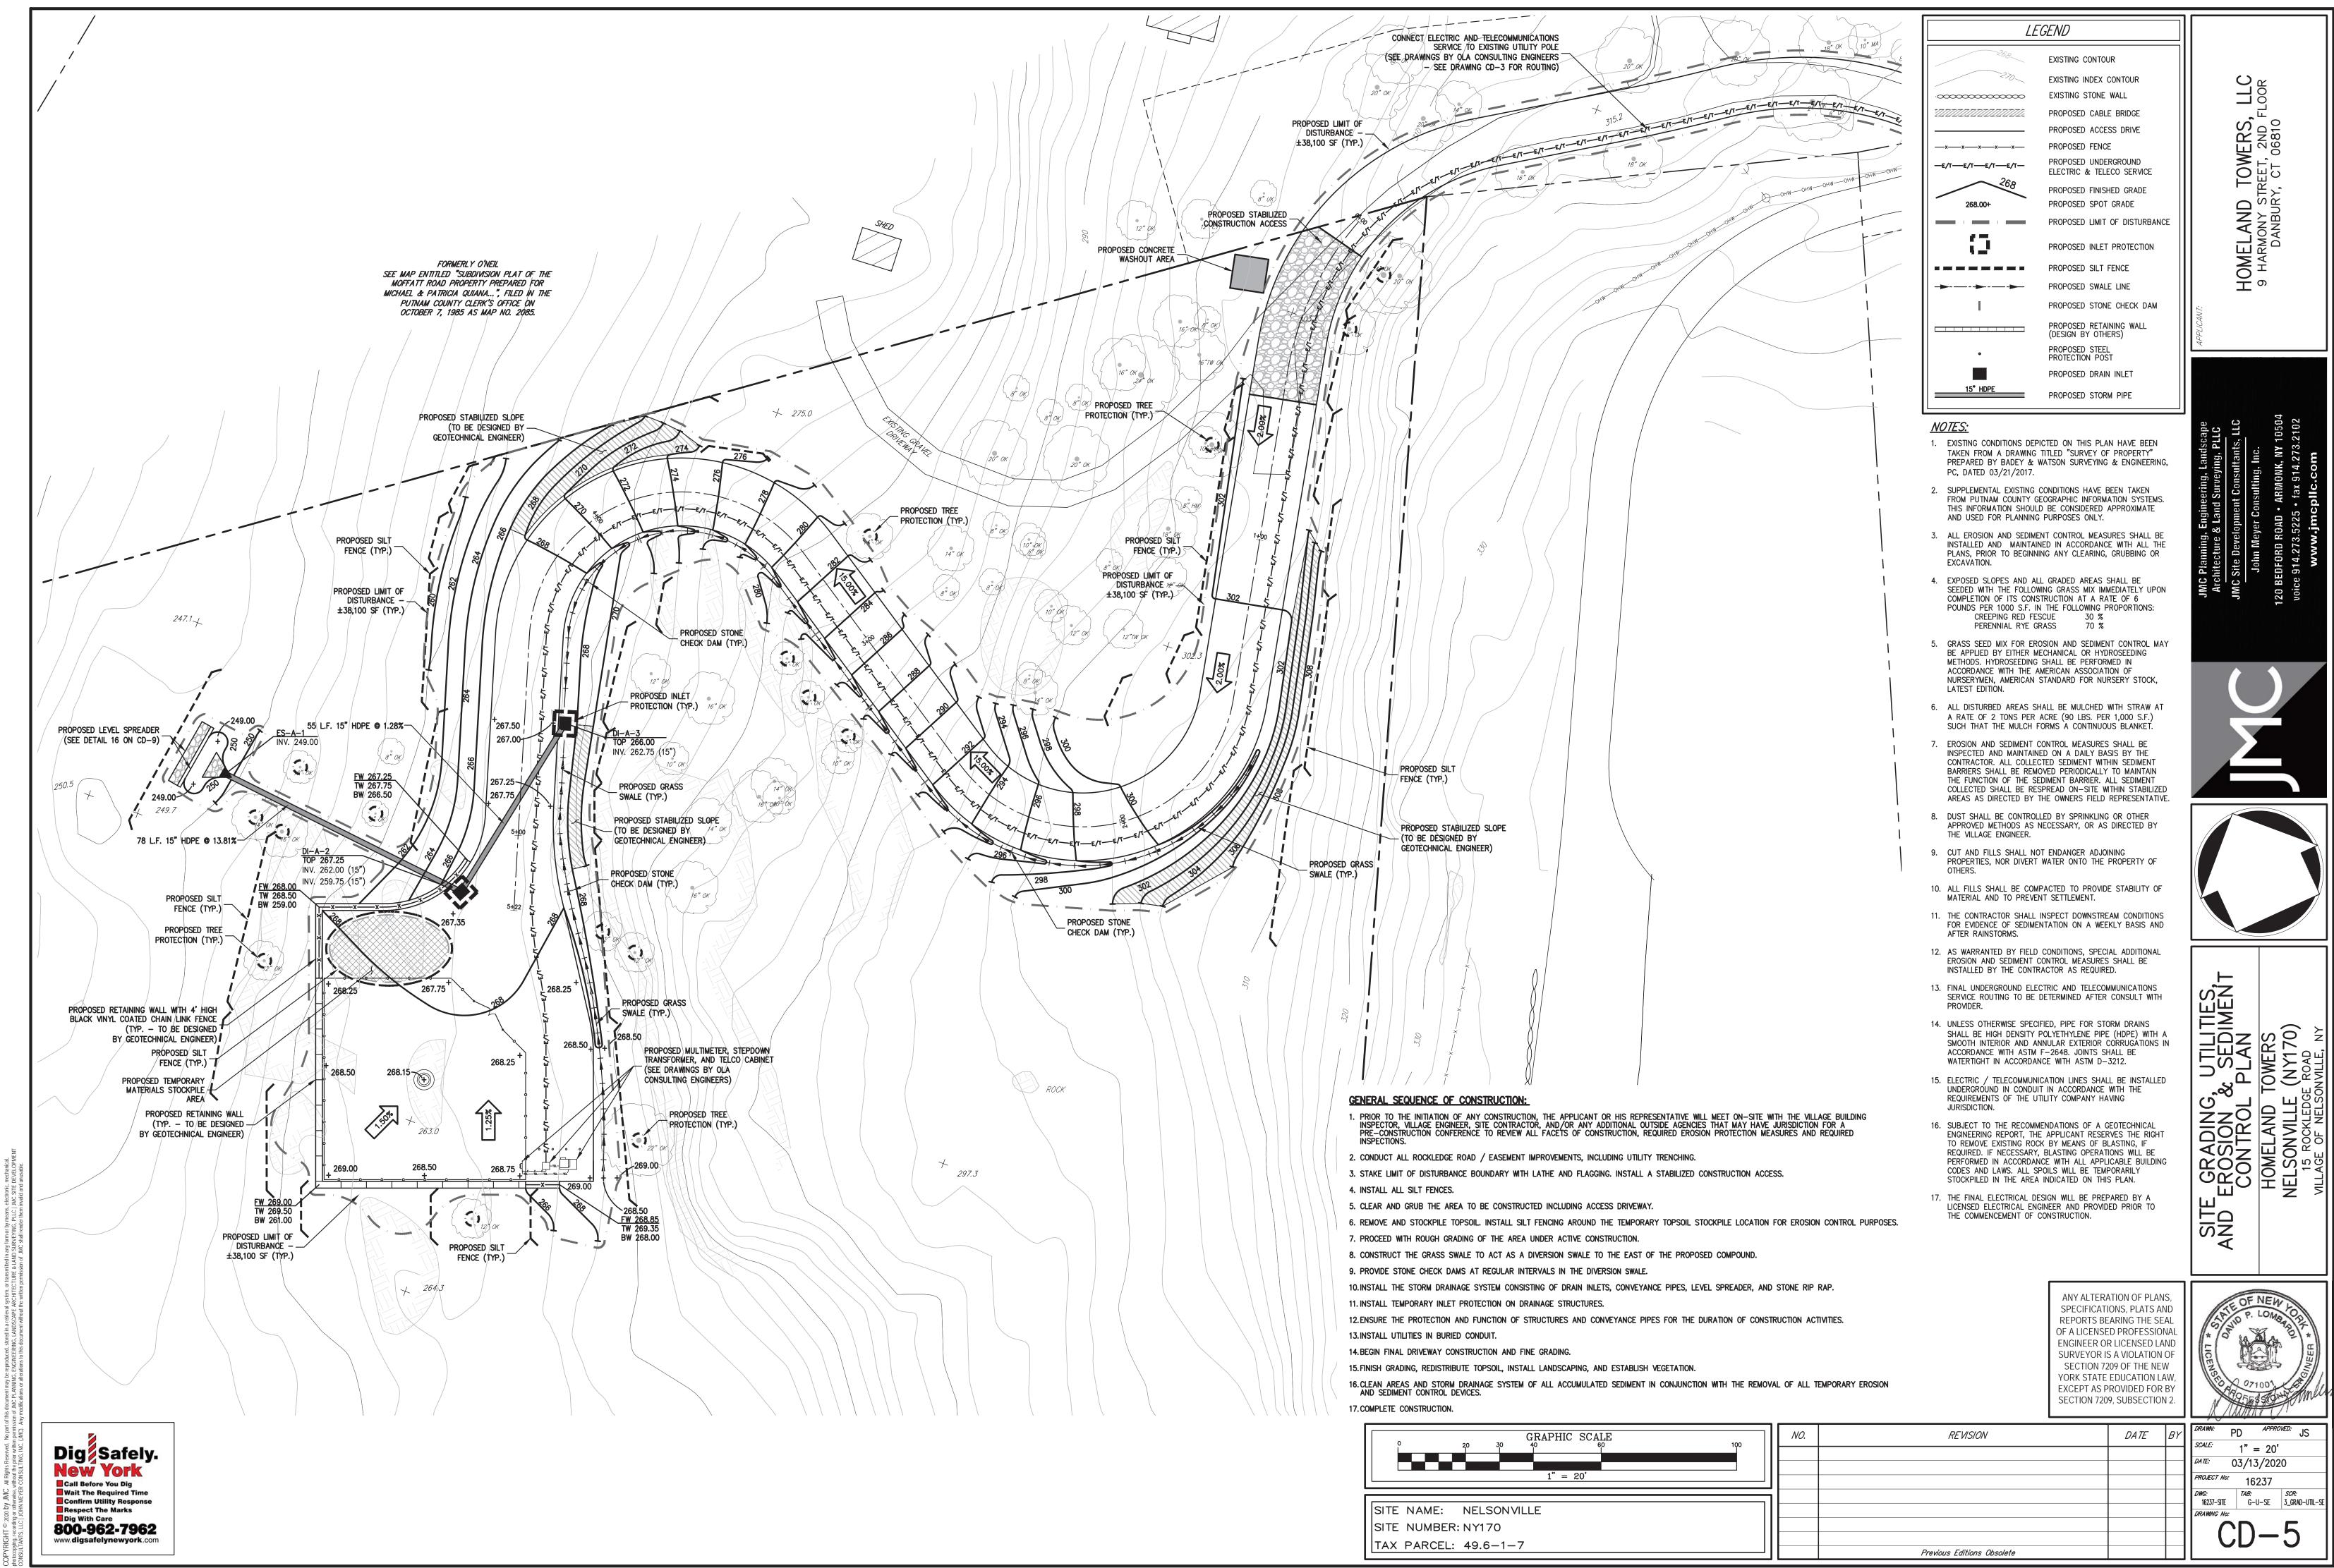

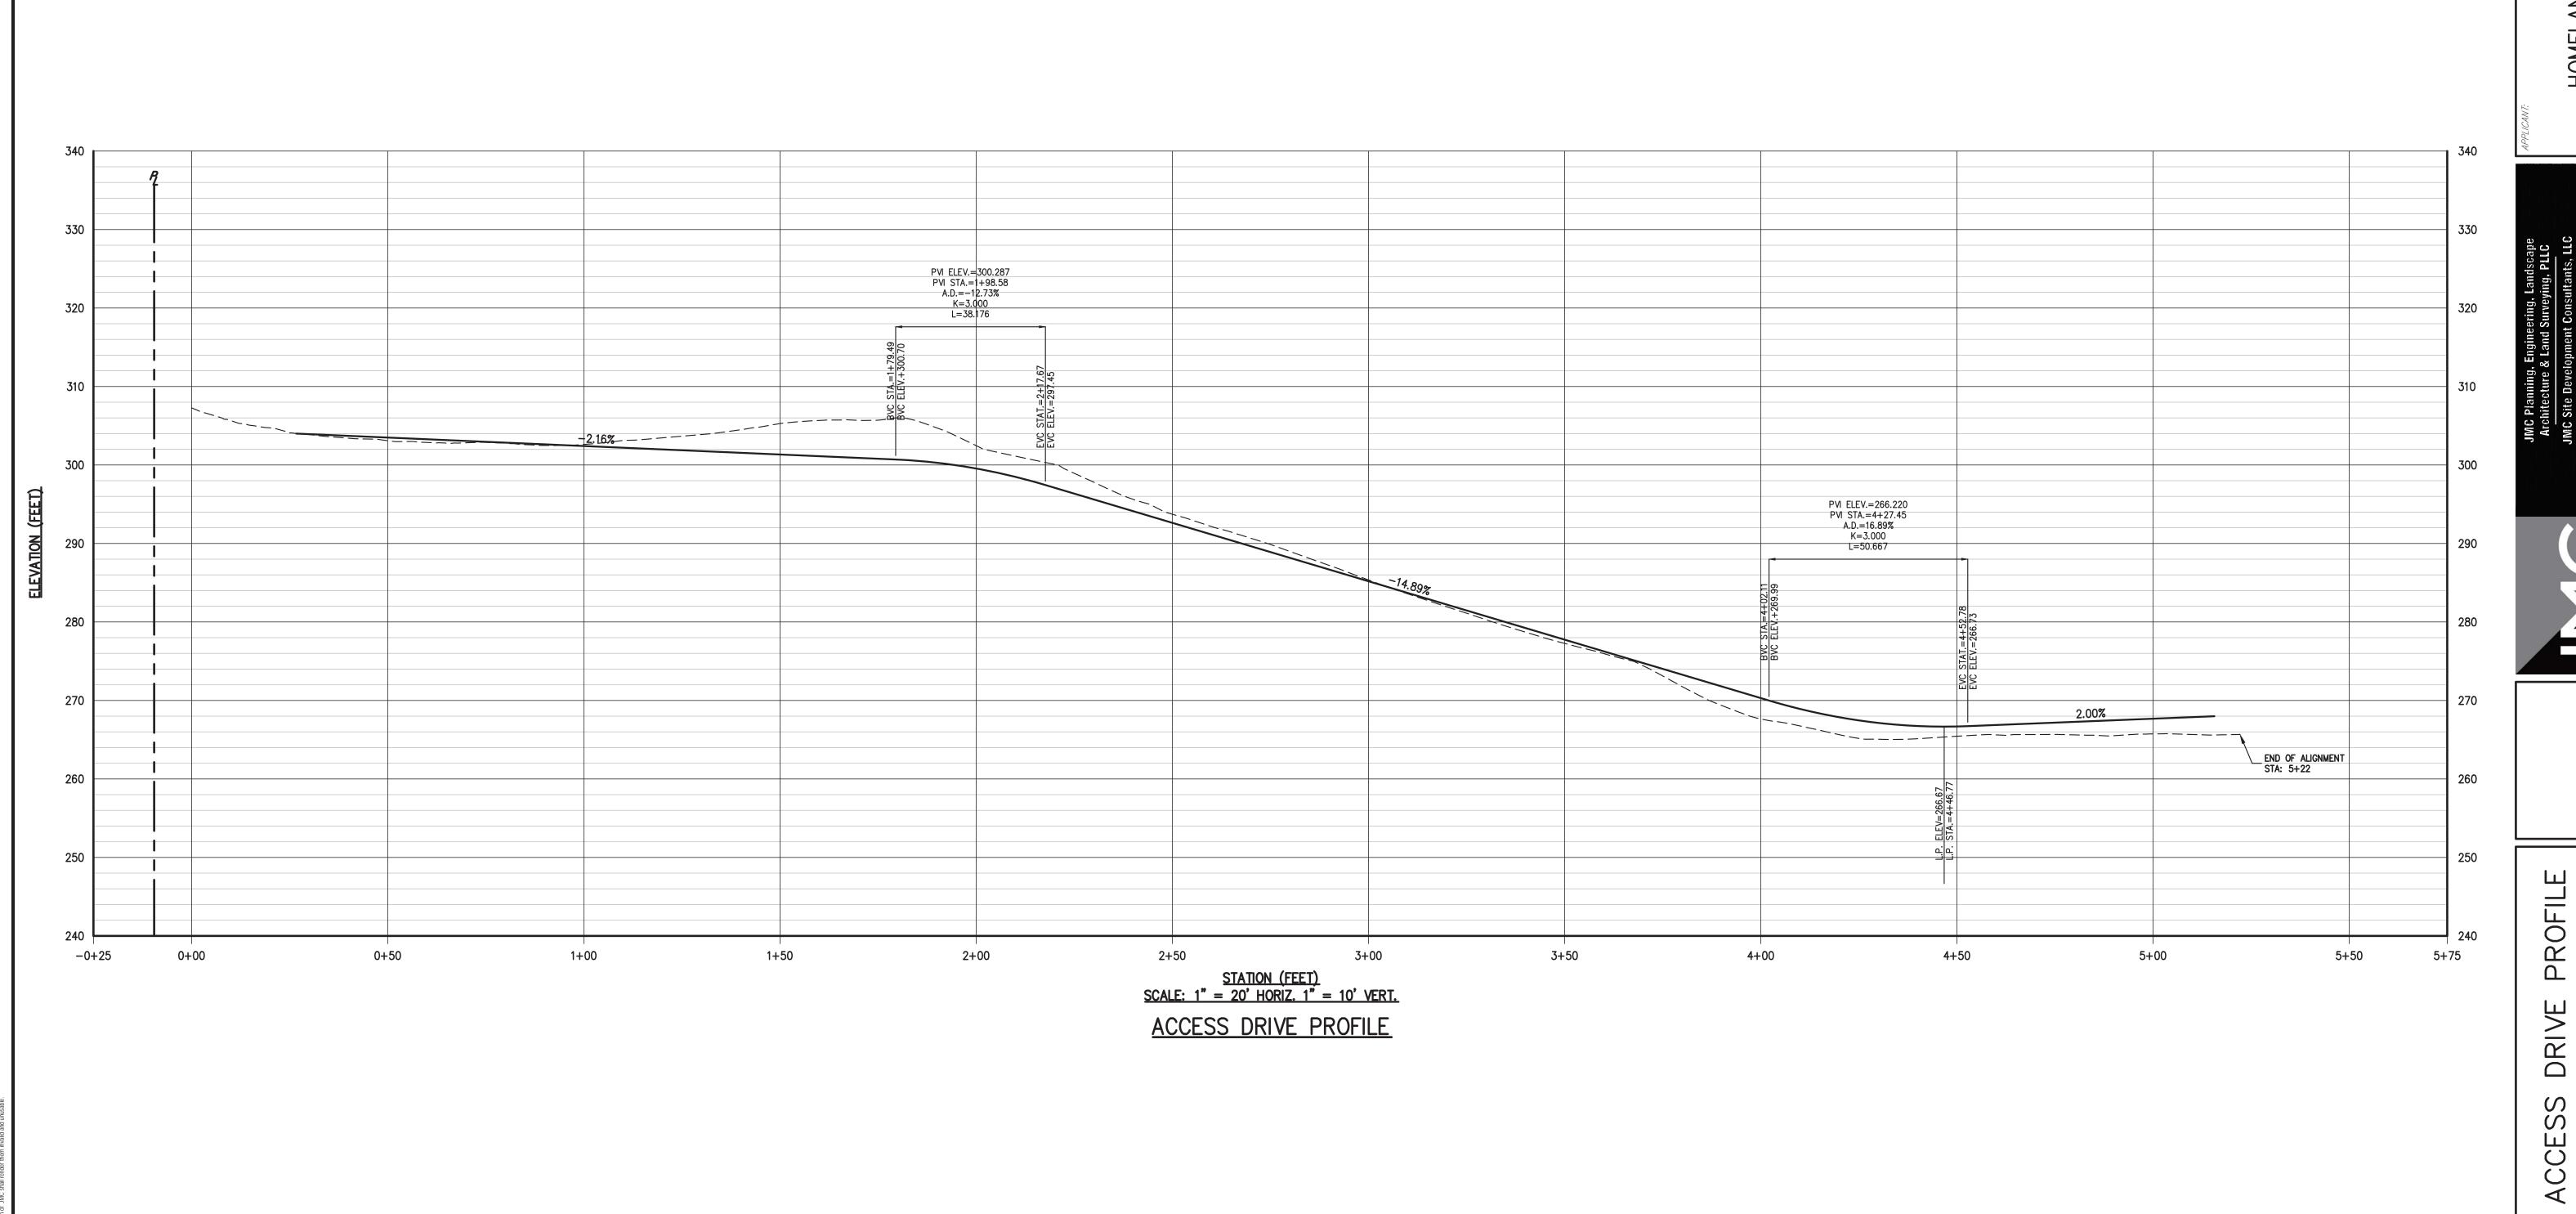

ANY ALTERATION OF PLANS,
SPECIFICATIONS, PLATS AND
REPORTS BEARING THE SEAL
OF A LICENSED PROFESSIONAL
ENGINEER OR LICENSED LAND
SURVEYOR IS A VIOLATION OF
SECTION 7209 OF THE NEW
YORK STATE EDUCATION LAW,
EXCEPT AS PROVIDED FOR BY
SECTION 7209, SUBSECTION 2.

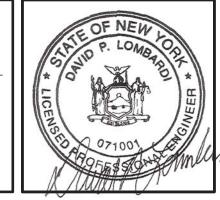

TOWERS: (NY170)
SE ROAD
SONVILLE: NY

ENGINEER OR LICENSED LAND SURVEYOR IS A VIOLATION OF SECTION 7209 OF THE NEW YORK STATE EDUCATION LAW, EXCEPT AS PROVIDED FOR BY SECTION 7209, SUBSECTION 2.

PROJECT NO: 100 APPROVED: JS SCALE: AS SHOWN

DATE: 03/13/2020

PROJECT NO: 100 APPROVED: JS SCALE: AS SHOWN

Previous Editions Obsolete

DATE BY

DRAWN: PD APPROVED: JS

SCALE: AS SHOWN

DATE: 03/13/2020

PROJECT NO: 16237

DIMG: TAB: SCR: 16237-SITE PROFILE 3_GRAD-UTIL-SE

DRAWNG NO:

CD-6



GRAPHIC SCALE

1" = 20'

SITE NAME: NELSONVILLE

SITE NUMBER: NY170

TAX PARCEL: 49.6-1-7

